


**50 NORTH-REFLECTED CEILING PLAN**

SCALE IN FEET

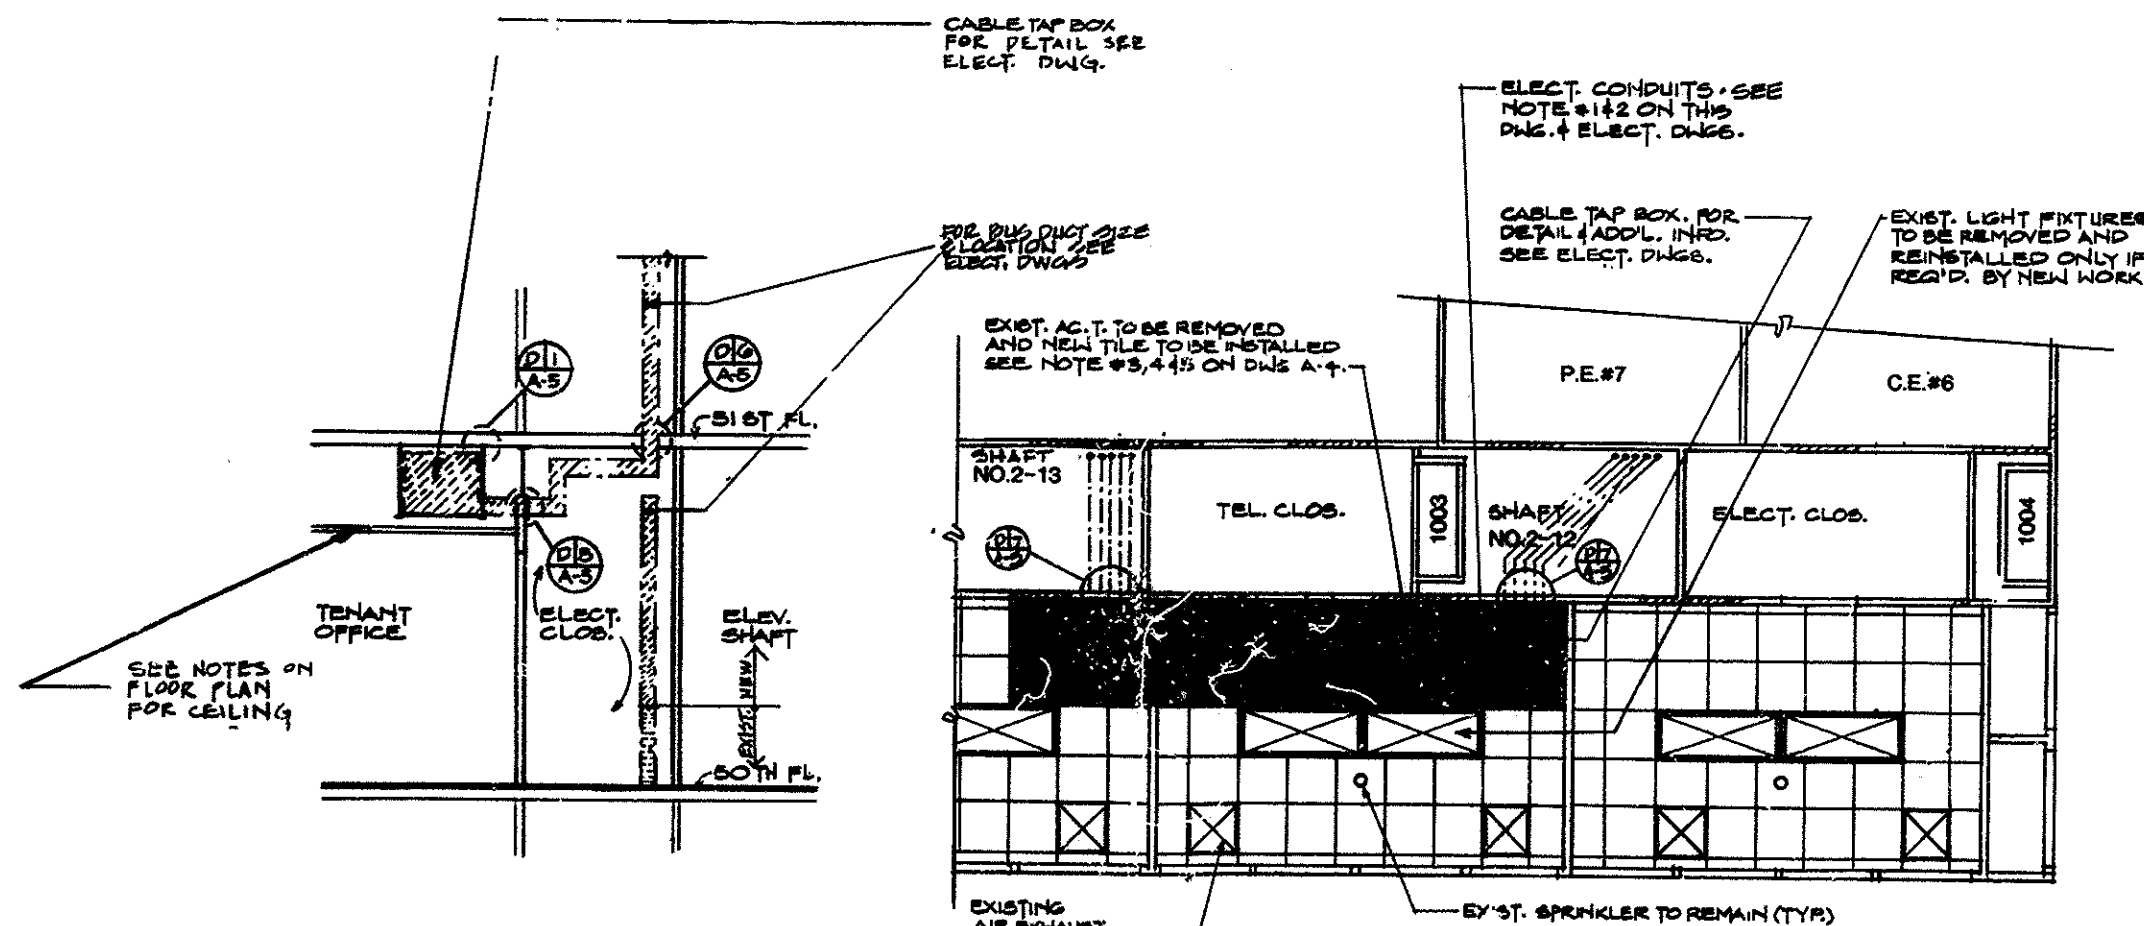


**48 SOUTH-REFLECTED CEILING PLAN**

SCALE IN FEET

**TYPICAL NOTES**

1. FOR EXACT ELECTRICAL CONDUITS & BUS DUCT LOCATIONS AND DETAILS SEE ELECTRICAL DRAWINGS.
2. THE CONTRACTOR SHALL PROVIDE METAL BRACKETS AS REQUIRED TO HOLD IN PLACE THE ELECTRICAL CONDUITS TO WALLS AND CEILINGS.
3. THE CONTRACTOR SHALL REMOVE AND RESTORE PORTION OF EXISTING CEILING INCLUDING GRID/SHOWN ON DRAWINGS AS REQUIRED FOR THE INSTALLATION OF NEW ELECTRICAL WORK. ALL DAMAGED GRID SYSTEM, SUPPORTS AND DEFECTIVE SPLINE SHALL BE REPLACED AS REQUIRED. NEW A.C. TILE TO BE INSTALLED TO MATCH EXISTING MATERIAL IN TEXTURE, COLOR & TYPE AT THE CONTRACTOR'S EXPENSE.
4. THE CONTRACTOR SHALL ALIGN ALL THE REPLACED ACOUSTICAL TILE TO THE EXISTING TILES THAT REMAIN ON CONSTRUCTION AS SHOWN ON PLAN.
5. EXISTING LIGHT FIXTURES SHALL BE REMOVED AND RE-INSTALLED. SEE LIGHT FIXTURE LEGEND ON DWG. #A-3. SEE ELECTRICAL DWGS FOR INSTALLATION.

SEE DWG. A-3 FOR LIGHT FIXTURE LEGEND

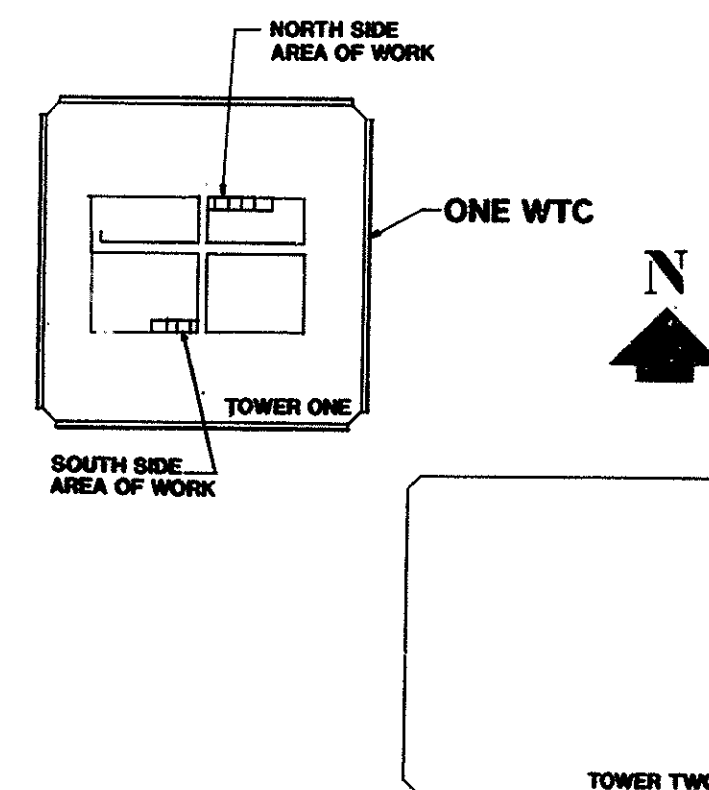

**KEY PLAN**  
NO SCALE

Sheet 7 of 41

**THE PORT AUTHORITY  
OF NY & NJ**

*James J. Frawley*  
Engineering Program Manager



3/15/01 Drawings of Record  
No. Date Revision Approved

Engineering Department  
Design Division

**The World Trade  
Center  
Electrical/HVAC  
Upgrade Program**

Title  
**LOW VOLTAGE DISTRIBUTION  
ONE WTC  
ARCHITECTURAL  
48TH FLOOR  
SOUTH SIDE  
50TH FLOOR  
NORTH SIDE  
REFLECTED CEILING  
PLANS & SECTION**

This drawing subject to conditions in contract.  
All inventions, ideas, designs and methods  
herein are reserved to Port Authority and  
may not be used without its written consent.

S.C.&M.S. S.C.&S.P.P.  
Designed by Drawn by Checked by

Date 10-4-93 Scale AS NOTED

Contract Number Drawing Number  
**WTC-304.041 A-4**